



- DESIGN NOTES:**
1. ALL WORK SHALL BE IN STRICT CONFORMANCE WITH ALL CURRENT APPLICABLE CODES AND REGULATIONS.
 2. HAND DIG PLANTING HOLE AND LOOSEN SURFACE SOIL.
 3. ALLOW FOR SETTLEMENT WHEN SETTING PLANTS. SET PLANTS 50mm HIGHER THAN ADJACENT FINISHED GRADE.
 4. BACKFILL SOIL IN 150mm LIFTS AND HAND TAMP TO PREVENT AIR POCKETS.
 5. CAREFULLY REMOVE ANY LOOSE SOIL FROM TOP OF ROOT BALL.

1 DECIDUOUS TREE PLANTING
1:20

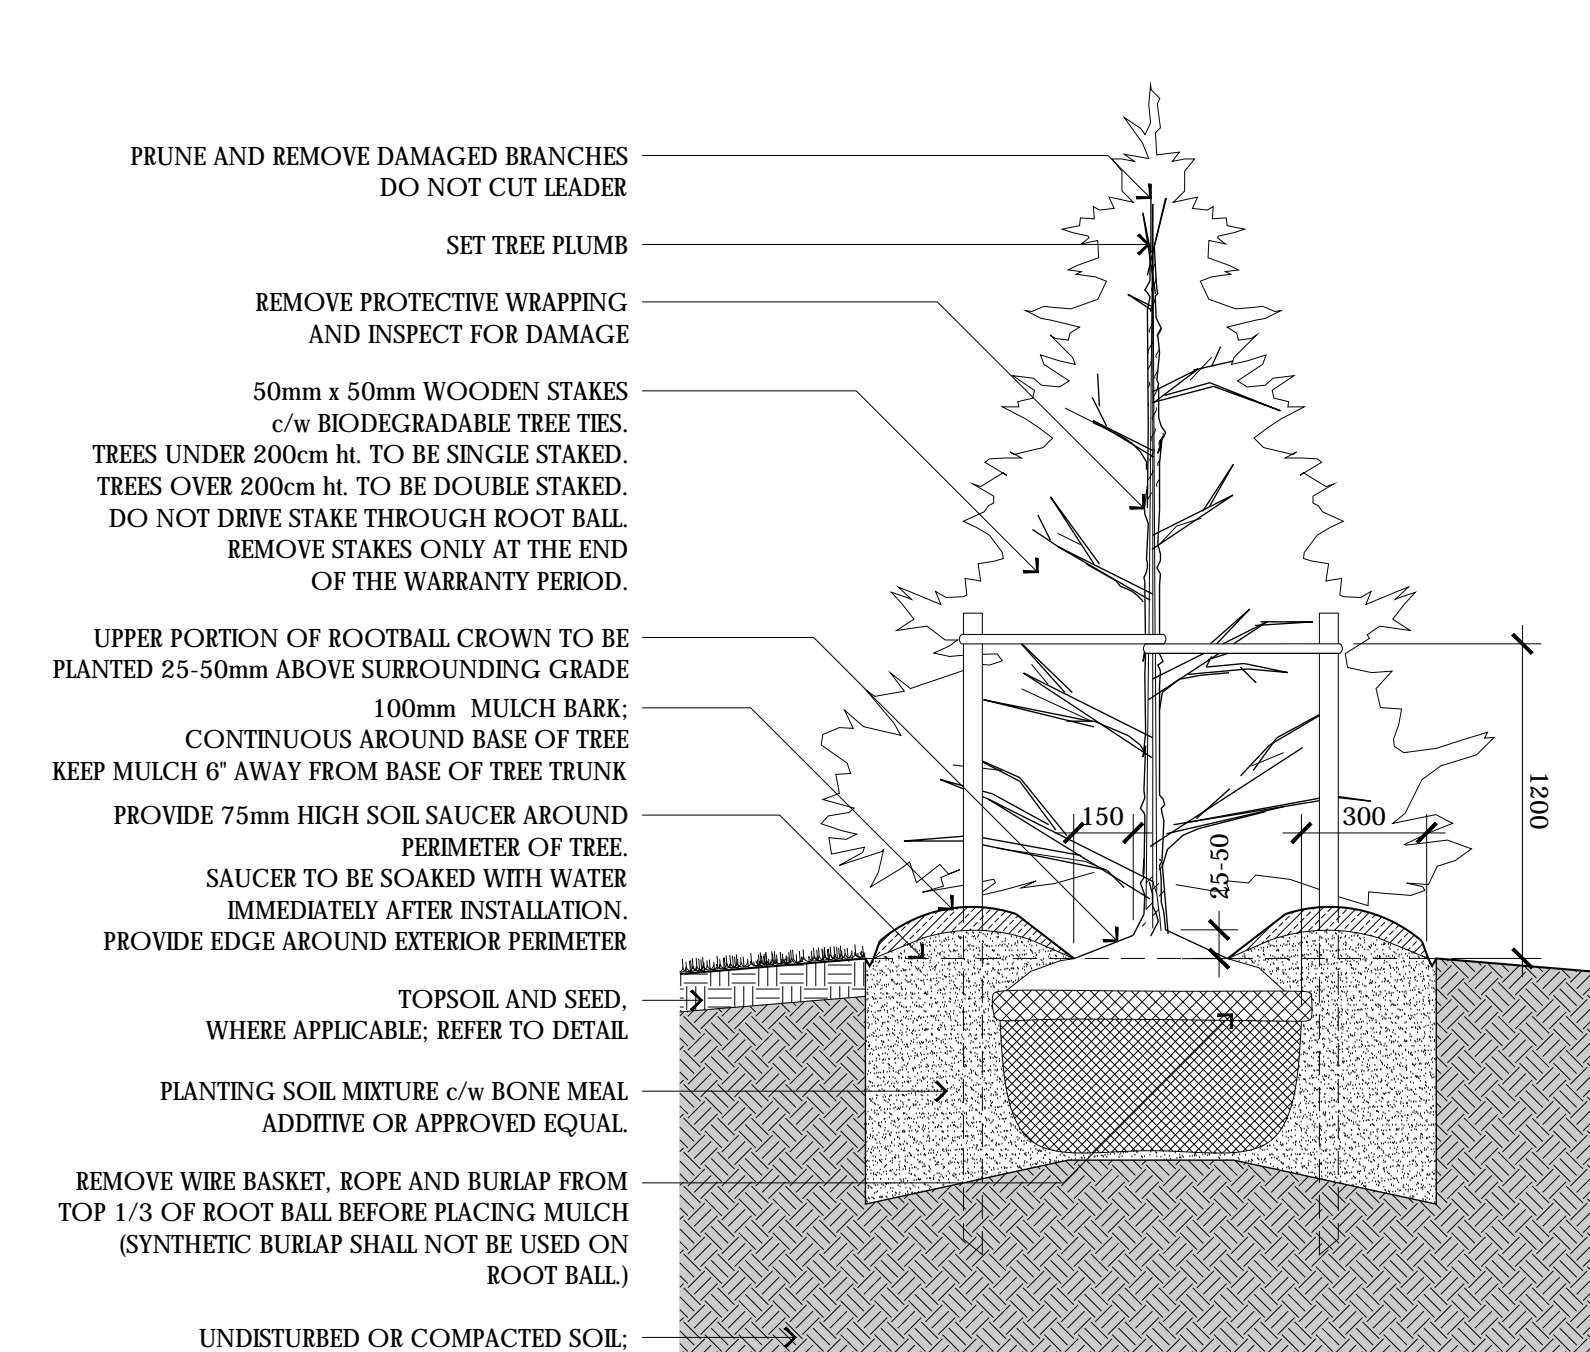


- GENERAL NOTES:**
1. ALL WORK SHALL BE IN STRICT CONFORMANCE WITH ALL CURRENT APPLICABLE CODES AND REGULATIONS.
 2. HAND DIG PLANTING HOLE AND LOOSEN SURFACE SOIL.
 3. ALLOW FOR SETTLEMENT WHEN SETTING PLANTS. SET PLANTS 50mm HIGHER THAN ADJACENT FINISHED GRADE.
 4. BACKFILL SOIL IN 150mm LIFTS AND HAND TAMP TO PREVENT AIR POCKETS.
 5. CAREFULLY REMOVE ANY LOOSE SOIL FROM TOP OF ROOT BALL.

2 CONIFEROUS TREE PLANTING
1:20

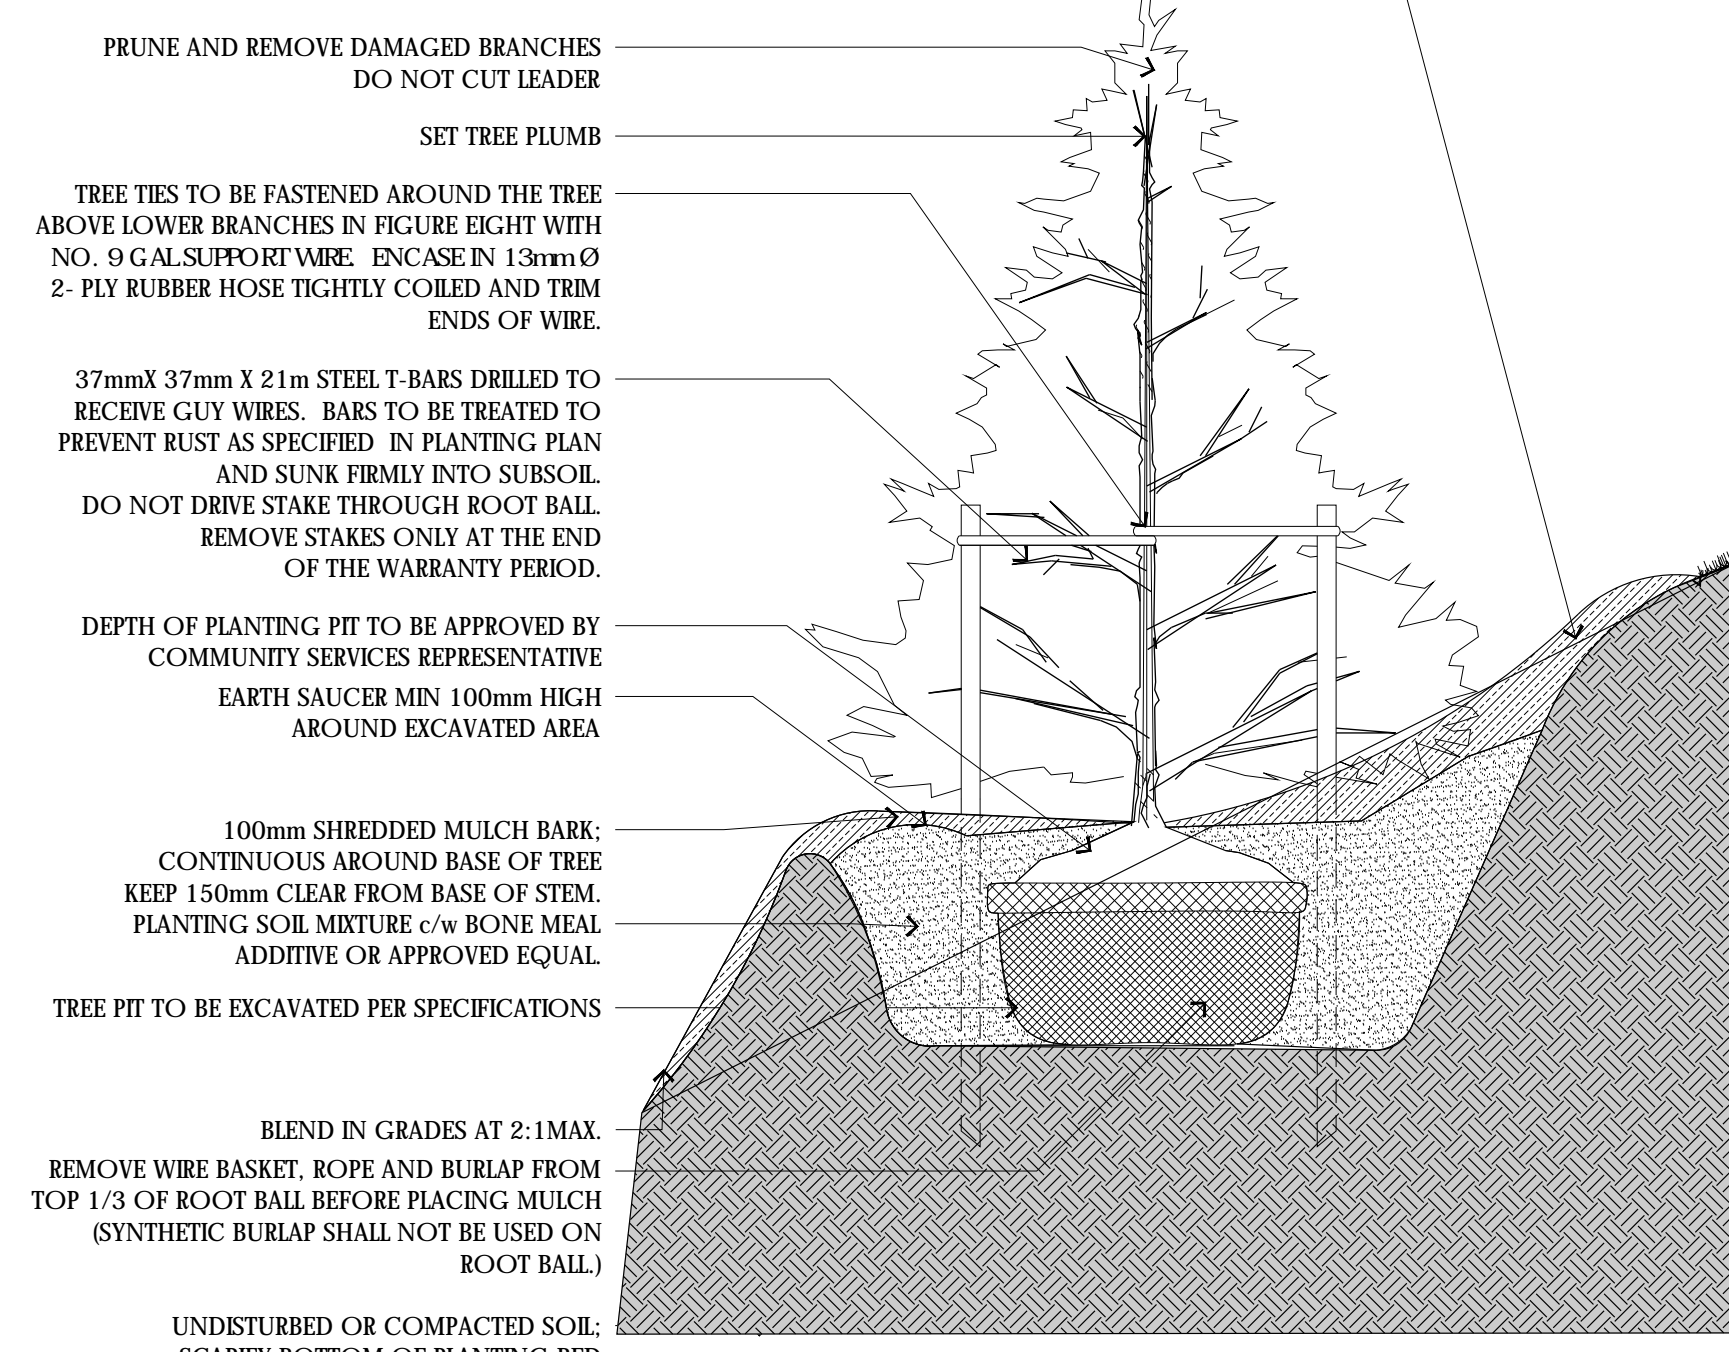


- GENERAL NOTES:**
1. ALL WORK SHALL BE IN STRICT CONFORMANCE WITH ALL CURRENT APPLICABLE CODES AND REGULATIONS.
 2. HAND DIG PLANTING HOLE AND LOOSEN SURFACE SOIL.
 3. ALLOW FOR SETTLEMENT WHEN SETTING PLANTS. SET PLANTS 50mm HIGHER THAN ADJACENT FINISHED GRADE.
 4. BACKFILL SOIL IN 150mm LIFTS AND HAND TAMP TO PREVENT AIR POCKETS.
 5. CAREFULLY REMOVE ANY LOOSE SOIL FROM TOP OF ROOT BALL.

3 TREE PLANTING ON SLOPE
1:20

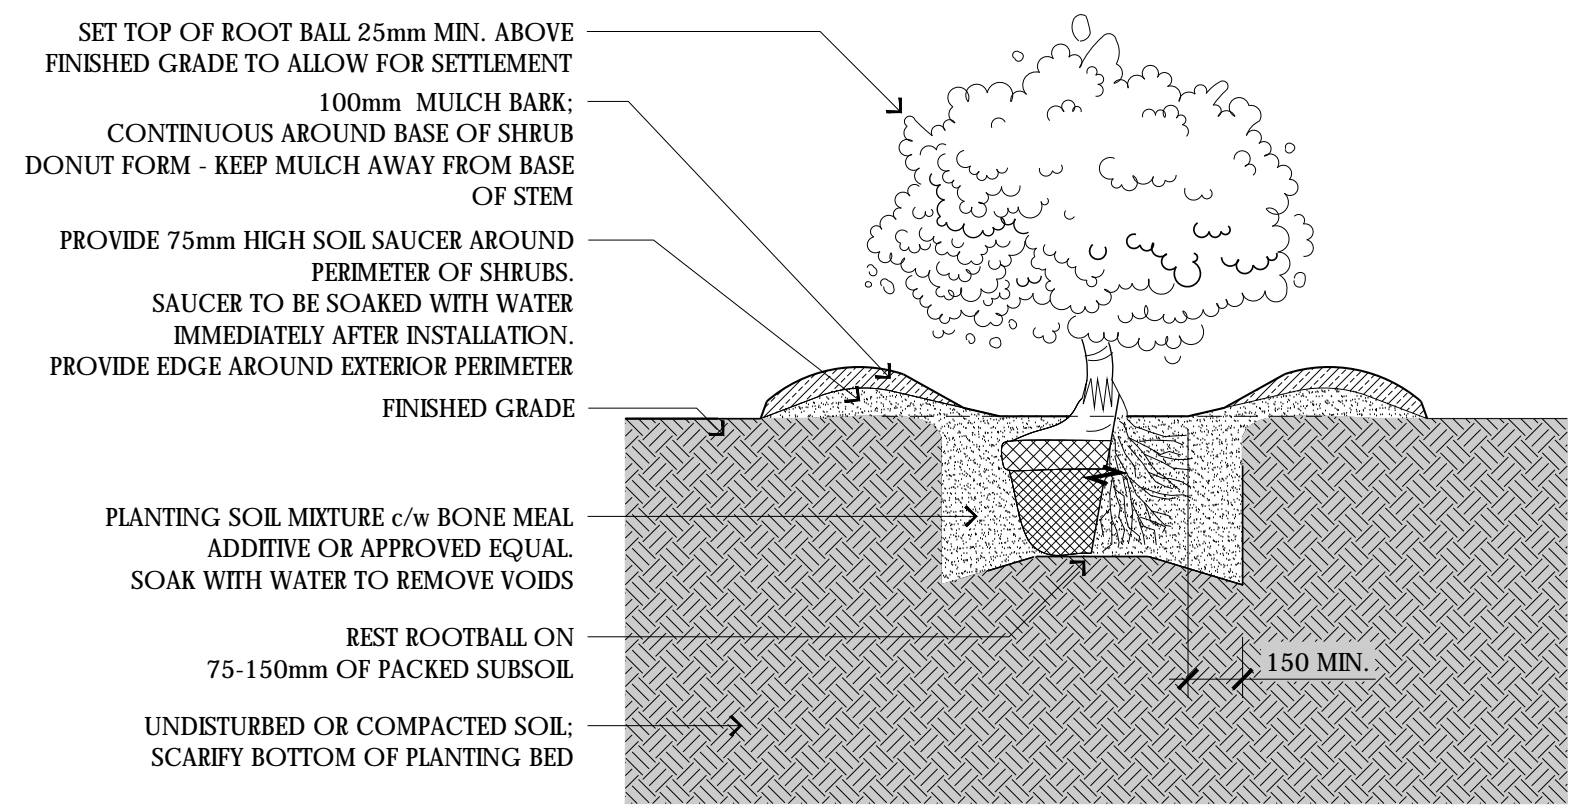

- DESIGN NOTES:**
1. ALL WORK SHALL BE IN STRICT CONFORMANCE WITH ALL CURRENT APPLICABLE CODES AND REGULATIONS.
 2. ROOT BALL TO BE 300mm UNLESS SPECIFIED OTHERWISE.
 3. 1/3 OF BURLAP TO BE ROLLED BACK. SPREAD ROOTS OVER COMPACTED SUBSOIL.
 4. PLANTING BEDS TO HAVE 75mm SHREDDED BARK MULCH.
 5. SAUCER OR BED TO BE SOAKED WITH WATER IMMEDIATELY AFTER PLANTING.

4 B&B BARE ROOT PERENNIAL & SHRUB PLANTING
1:20

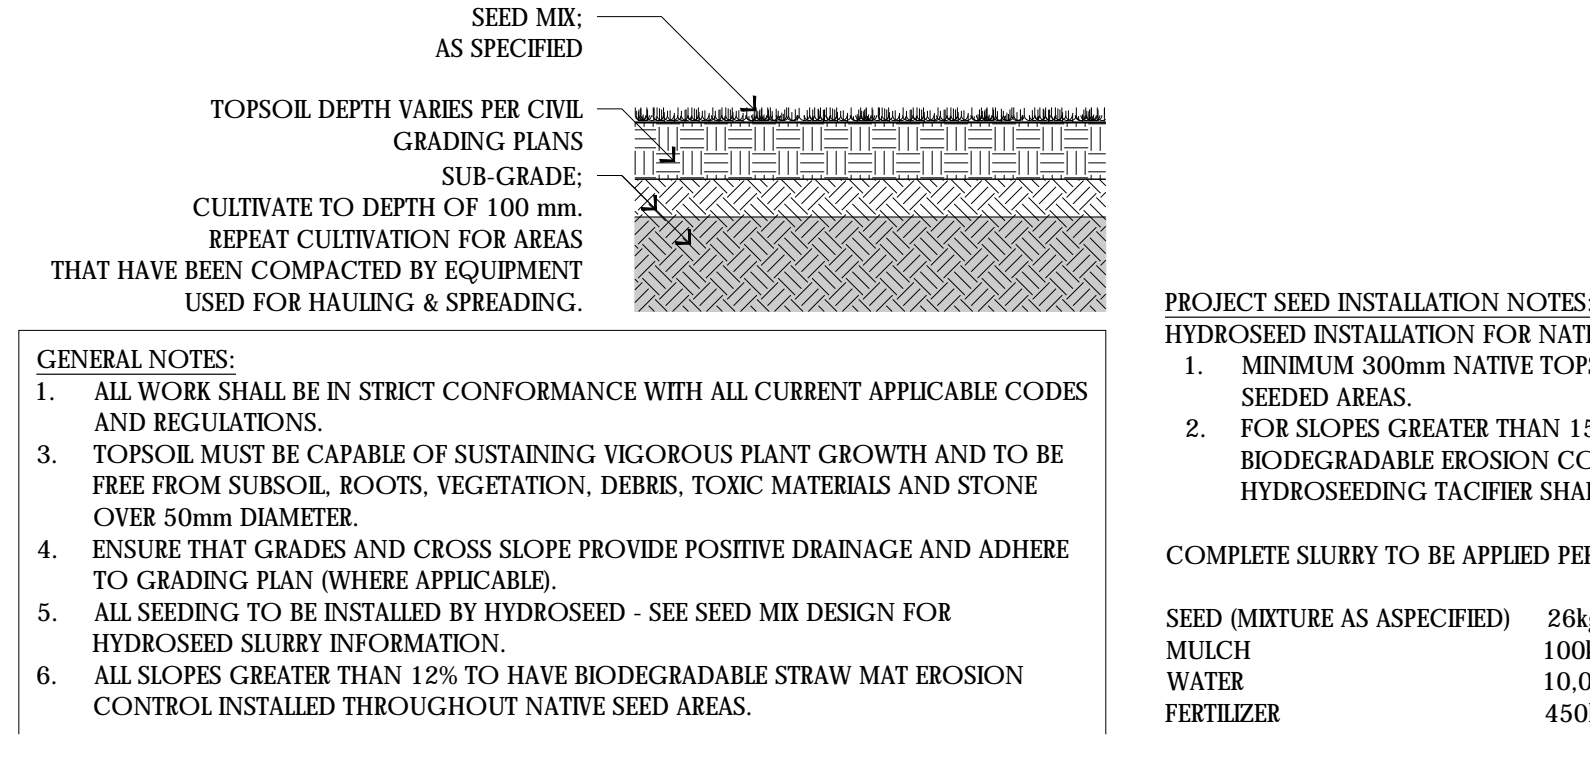

- GENERAL NOTES:**
1. ALL WORK SHALL BE IN STRICT CONFORMANCE WITH ALL CURRENT APPLICABLE CODES AND REGULATIONS.
 2. TOPSOIL MUST BE CAPABLE OF SUSTAINING VIGOROUS PLANT GROWTH AND TO BE FREE FROM SUBSOIL, ROOTS, VEGETATION, DEBRIS, TOXIC MATERIALS AND STONE OVER 50mm DIAMETER.
 3. ENSURE THAT GRADES AND CROSS SLOPE PROVIDE POSITIVE DRAINAGE AND ADHERE TO GRADING PLAN (WHERE APPLICABLE).
 4. ALL SEEDING TO BE INSTALLED BY HYDROSEED - SEE SEED MIX DESIGN FOR HYDROSEED SLURRY INFORMATION.
 5. ALL SLOPES GREATER THAN 12% TO HAVE BIODEGRADABLE STRAW MAT EROSION CONTROL INSTALLED THROUGHOUT NATIVE SEED AREAS.

Upland Meadow Seed Mix

| Botanical Name | Common Name | |
|------------------------------------|--------------------------|------------|
| Anaphalis margaritacea | Pearly Everlasting | 2% |
| Anemone virginiana var. virginiana | Tall Thimbleweed Variety | 2% |
| Apocynum cannabinum | Indian hemp | 3% |
| Asclepias syriaca | common milkweed | 3% |
| Eupatorium rugosum | white snakeroot | 2% |
| Monarda fistulosa | wild bergamot | 2% |
| Oenothera biennis | evening primrose | 2% |
| Rudbeckia hirta | black-eyed susan | 6% |
| Solidago altissima | tall goldenrod | 5% |
| Solidago canadensis | Canada goldenrod | 4% |
| Solidago gigantea | giant goldenrod | 3% |
| Symphoricarpon ericoides | heath aster | 2% |
| Symphoricarpon novae-angliae | New England aster | 2% |
| Verbena officinalis | White Vervain | 2% |
| Total Wildflower | | 40% |

Grass-like Species

| Botanical Name | Common Name | |
|----------------------|-----------------------|------------|
| Carex plantaginea | Plantain-leaved Sedge | 6% |
| Carex rosea | Rosy Sedge | 6% |
| Elymus hystrix | Bottlebrush Grass | 24% |
| Elymus virginicus | Virginia wild rye | 24% |
| Total Grasses | | 60% |


Application rate of 26kg/ha

Cover Crop: (BOTH SEED MIXES TYP.)

| | Common Oats | |
|--------|----------------------|------------------|
| 33.30% | Avena sativa | Common Oats |
| 33.30% | Fagopyrum esculentum | Buckwheat |
| 33.30% | Lolium multiflorum | Annual Ryegrass* |


* Note not to be confused with Perennial Rye (Lolium perenne)

5 NATIVE MEADOW SEEDING
1:20

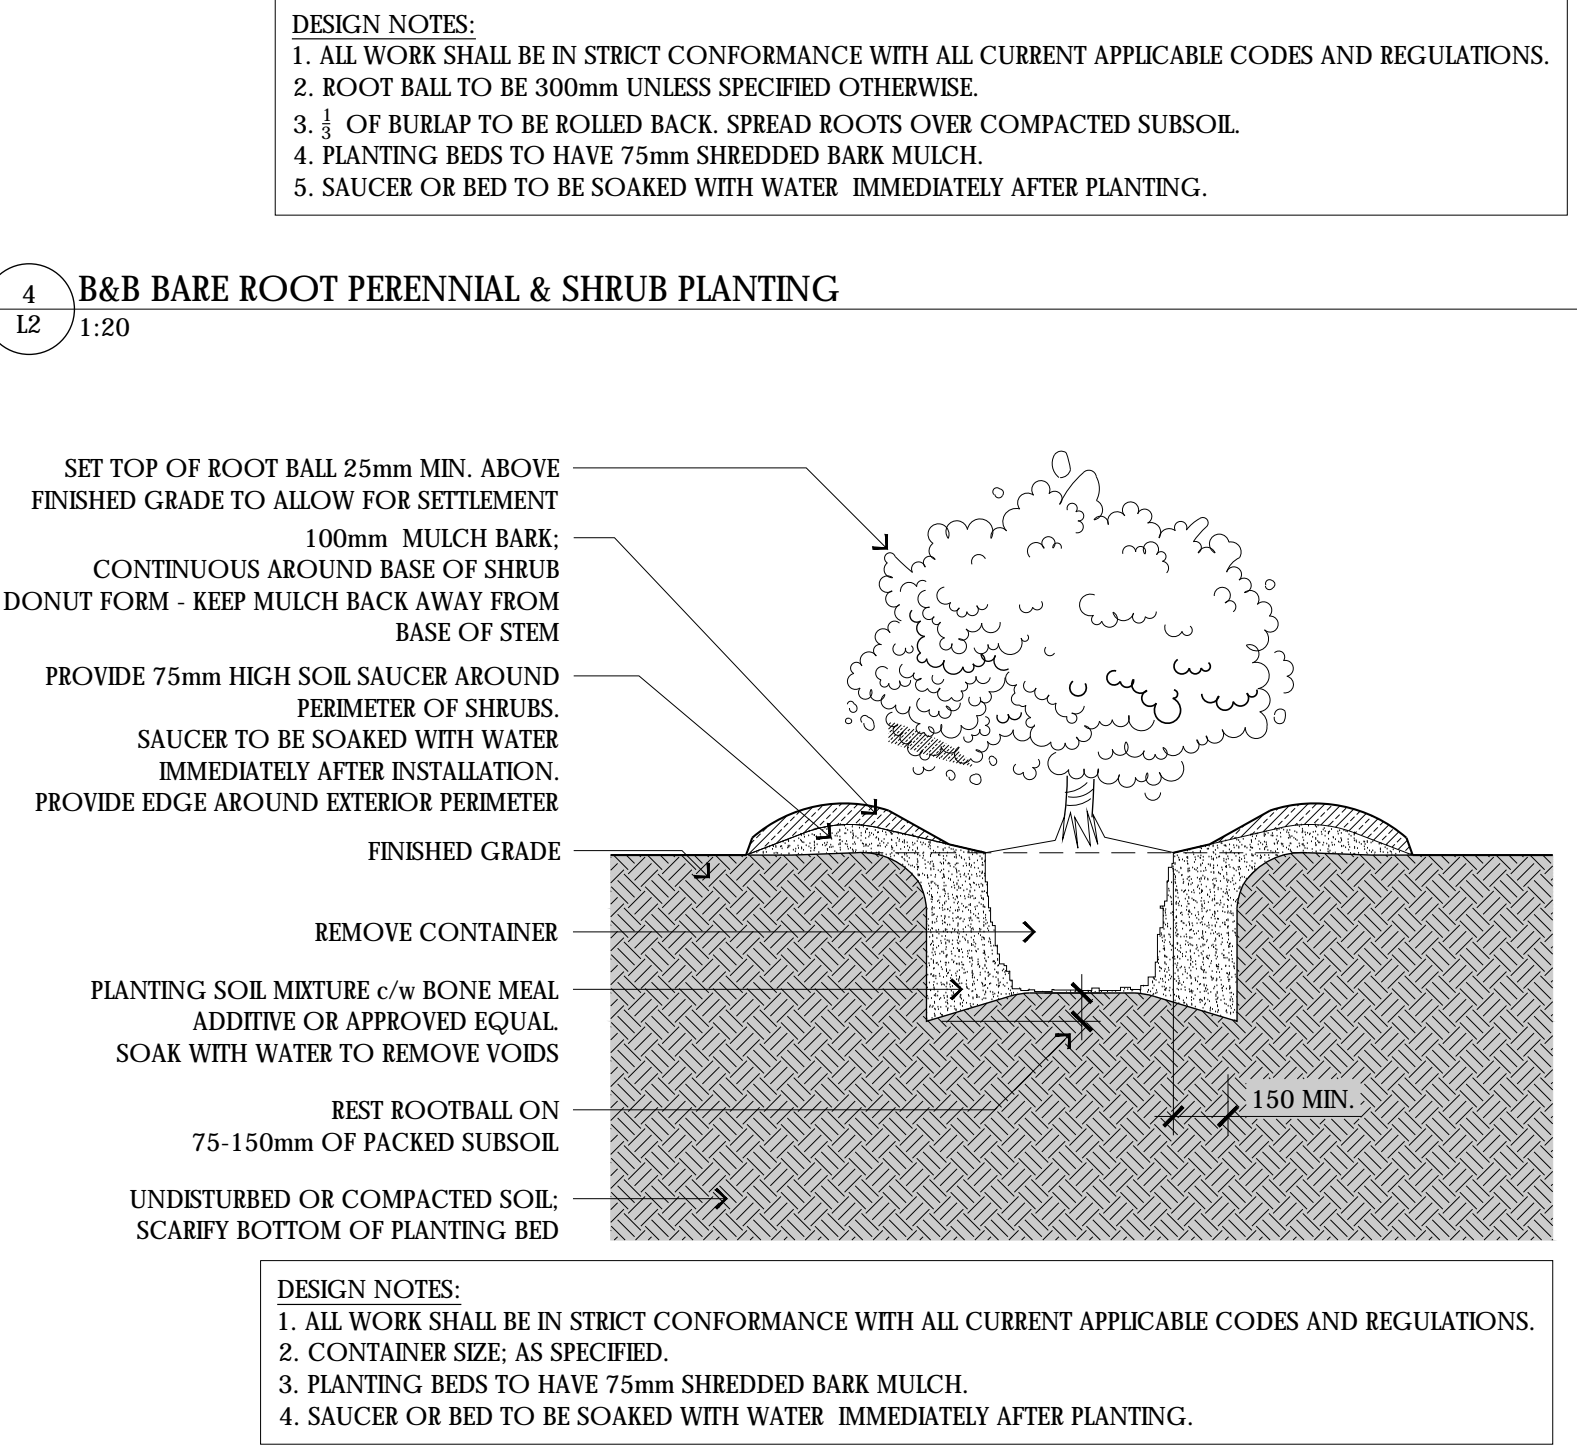

- DESIGN NOTES:**
1. ALL WORK SHALL BE IN STRICT CONFORMANCE WITH ALL CURRENT APPLICABLE CODES AND REGULATIONS.
 2. CONTAINER SIZE: AS SPECIFIED.
 3. PLANTING BEDS TO HAVE 75mm SHREDDED BARK MULCH.
 4. SAUCER OR BED TO BE SOAKED WITH WATER IMMEDIATELY AFTER PLANTING.

5 CONTAINER-STOCK PERENNIAL & SHRUB PLANTING
1:20

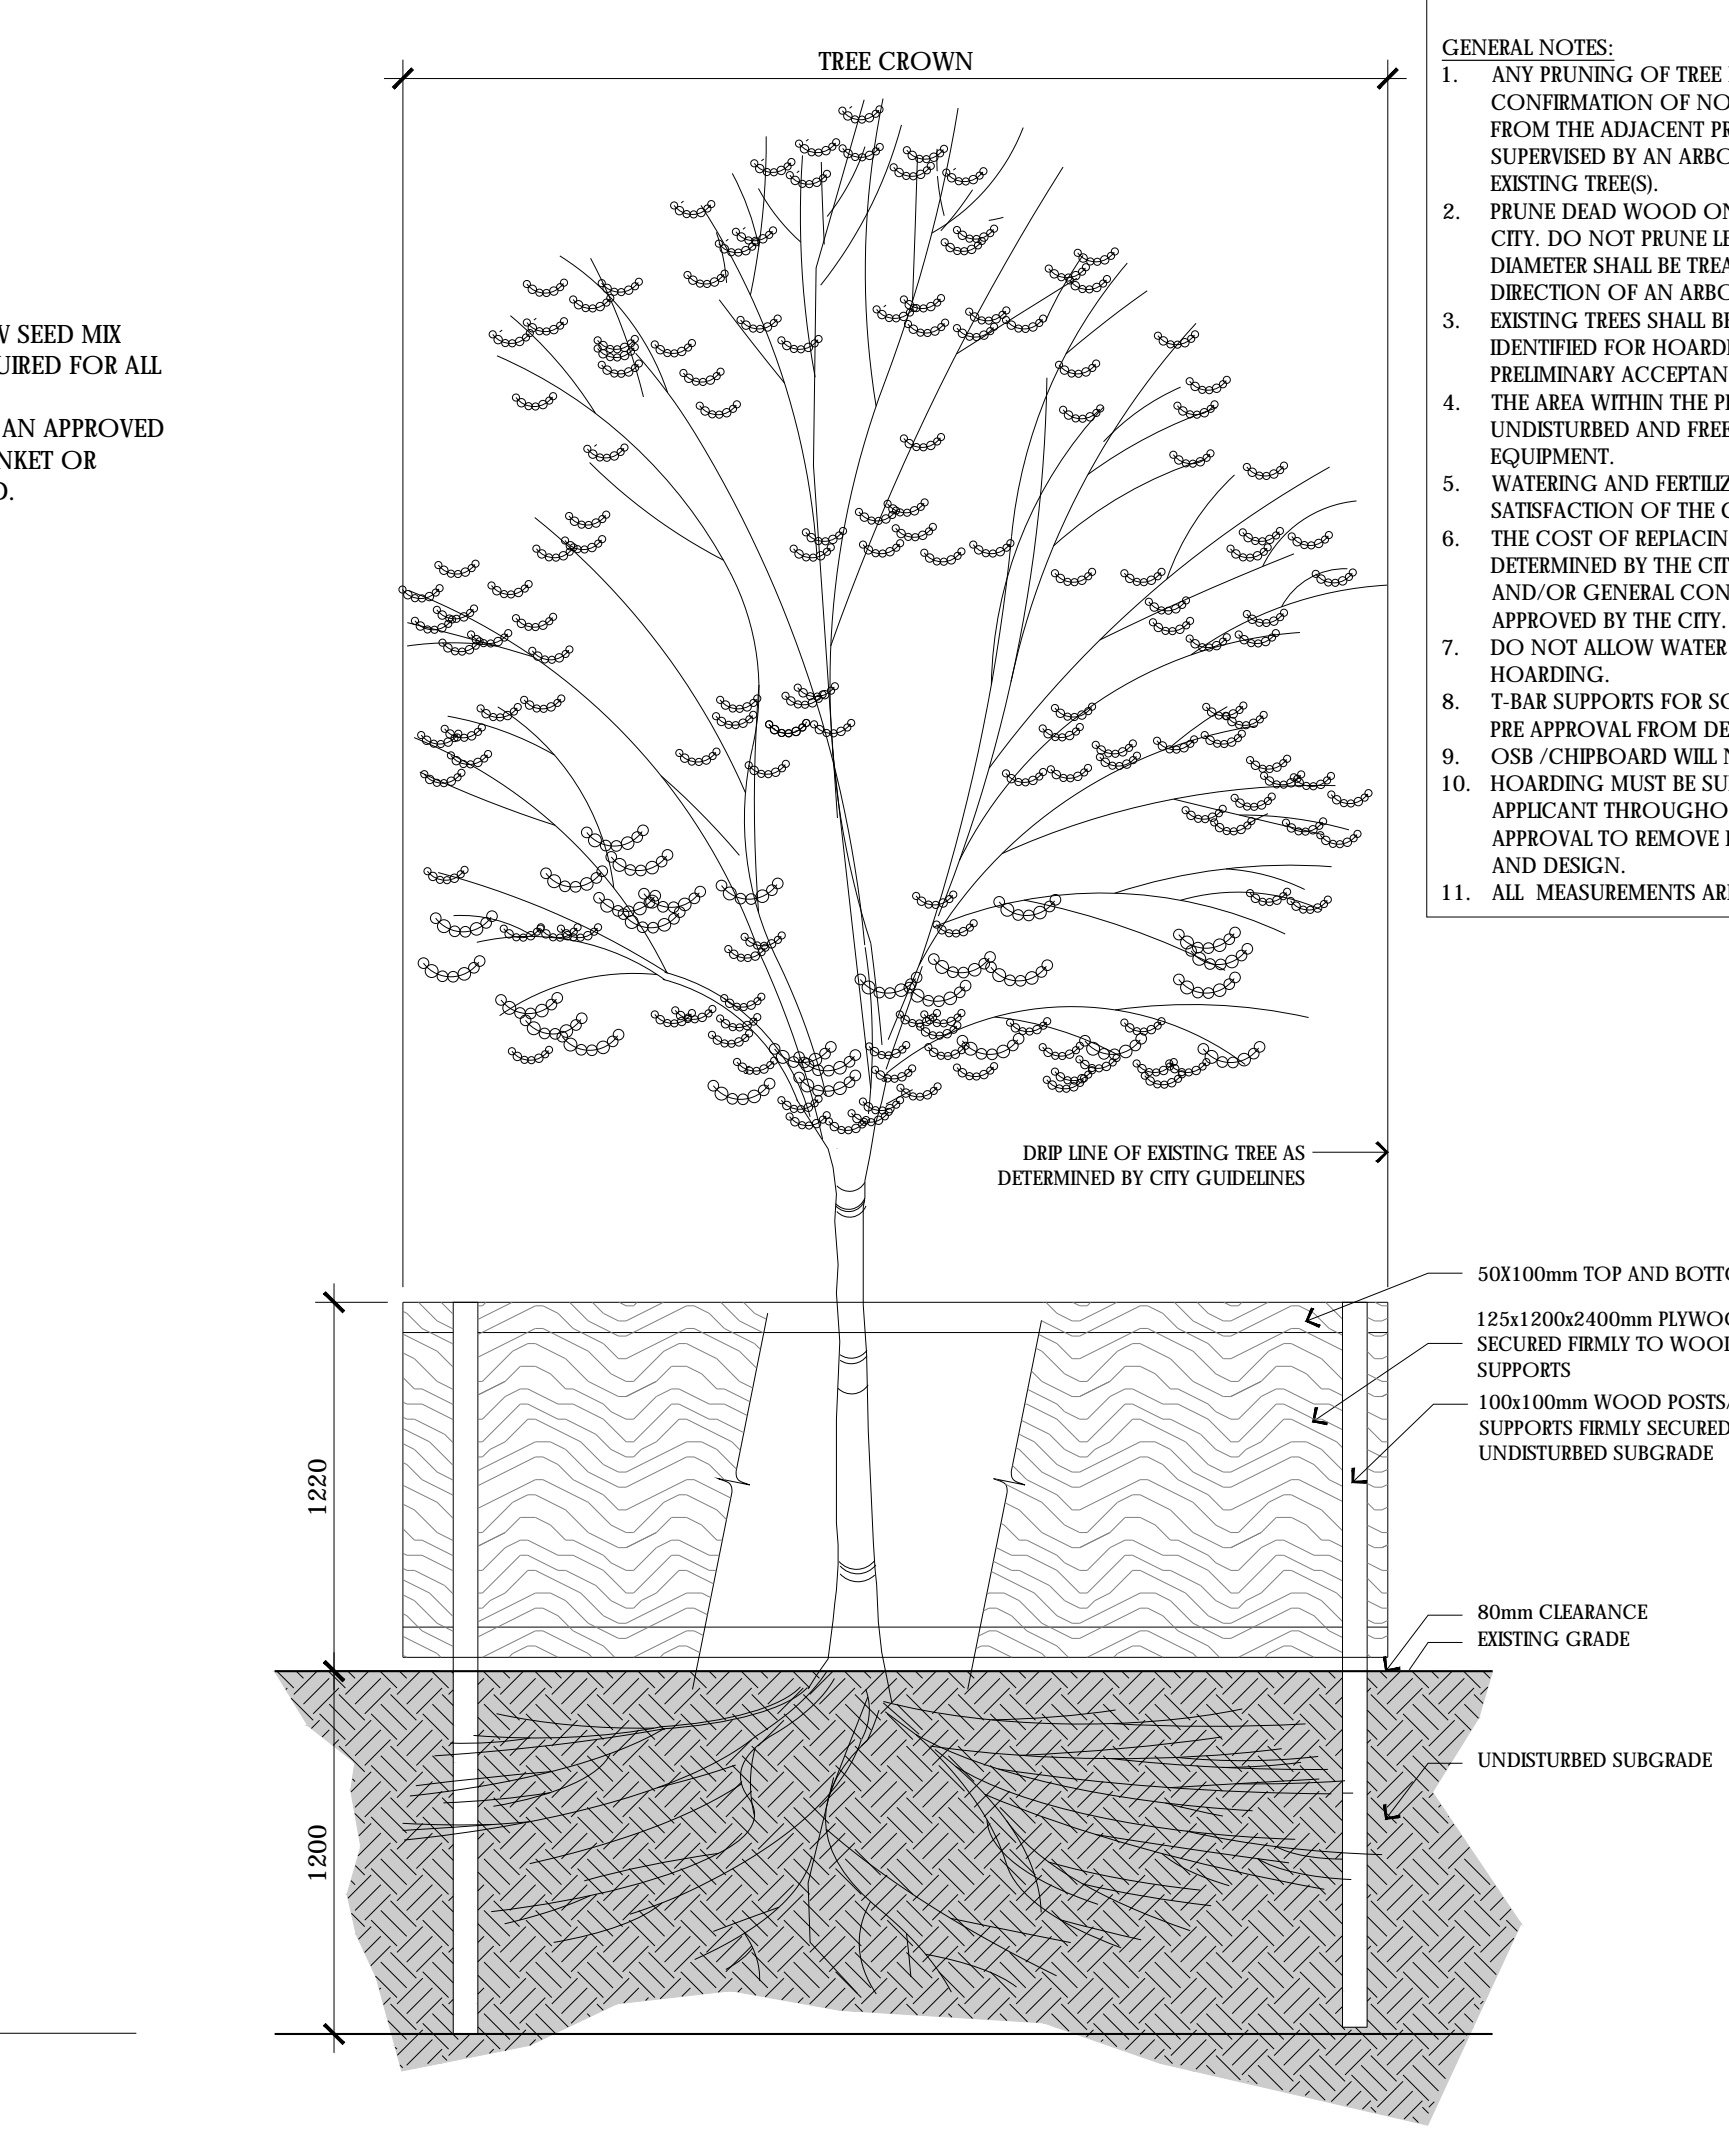

7 TEMPORARY TREE PRESERVATION HOARDING
1:25

We have relied upon the accuracy and completeness of base & background information provided by the following Consultants in preparing this drawing and performing our professional services.

Graen Properties Design
S.D. McLaren, OLS

Hahn Waldorf
S.D. McLaren, OLS


We are under no obligation or duty to verify the accuracy and/or completeness of this information and have not done so. We shall not be held responsible for any errors or omissions that may arise or be incorporated as a result of erroneous or incomplete information provided by the Client, Consultants and Contractors.

| No. | Date (Y/M/D) | Issue / Revision | By |
|-----|--------------|---------------------------|----|
| 7 | 190703 | ISSUED FOR SUBMISSION | KF |
| 4 | 190402 | ISSUED FOR TENDER | KF |
| 3 | 190306 | ISSUED FOR 1st SUBMISSION | KF |

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ENVIRONMENTAL POLICY · URBAN DESIGN
COMMUNITY ENGAGEMENT

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The contractor will check and verify all dimensions and job conditions on the site and report any discrepancies to the Landscape Architect prior to the commencement of construction.

This drawing must not be used for construction purposes until signed by the Landscape Architect.
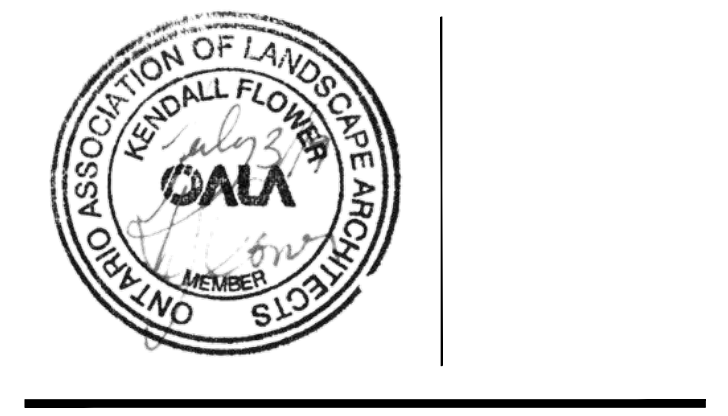
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DO NOT SCALE DRAWING

Project Info:
HALTON WALDORF - HIGHSCOOL
2254 Orchard Road, Burlington

Client Info:
Halton Waldorf School
2193 Orchard Rd., Burlington
(905) 331-4387

Sheet Title:
PLANTING DETAILS

Project Number: 1813
Drawn By: kf
Checked By: kf
Date: February 2019
Scale: AS SHOWN

Sheet Number:
L2